PAVED ALLEYWAY (N30°00'E 59.00') N28°05'54"E 58.90' TWO CAR EXIST. CONC. WALL DETACHED GARAGE EXIST. CONCRETE STEPS PORTION 3 TENT PORTION 2 TENT EXIST. WOOD RETAINING CONC. PAD WALL — N60°00'W 119.69' (N60°00'W 120.00') ROOF OVERHANG ABOVE 120.00, **NEW COVERED** CONCRETE SLAB EXISTING WOOD DECK TO BE REMOVED— 523.49' (LOW PT.) 523 RELOCATE MECH. units — 524 PORTION 2 TENT PORTION 1 TENT (HIGH PT.) EXG. TWO-STORY - NEW STAIR BUMPOUT 526 WOOD FRAME CONCRETE **RETAINING WALL** HOUSE EXPOSED WOOD/STEEL ARBOR F.F. 533.48¹ NEW CONCRETE STAIRS -NEW CONCRETE RETAINING WALL 530.39' (H**I**GH P1 EXISTING COVERED WOOD PORCH PORTION 1 TENT NEW CONC. STEPS CONCRETE WALK //

HIGHLAND AVENUE

\$30°00'00"W 59.00'

SITE PLAN

(22X34 SHEET) SCALE= 1"=10'-0" (11X17 SHEET) SCALE= 1"=20'-0"

NEW INTERIOR SPACE ADDITION ON SITE



DEMO EXIST. ITEM ON SITE



EXIST. TREE TO BE REMOVED

NEW TREE TO BE PLANTED

EXIST. TREE TO BE PROTECTED



LEGEND UTILITY POLE PP ● **GUY WIRE** OVERHEAD ELEC. ——— OE ——— WATER METER WM 🔾 IRON ROD FOUND IRON PIPE FOUND WOOD FENCE

TABLE OF CONTENTS

SP1: SITE PLAN A1.0: FIRST FLOOR PLAN

METAL FENCE

- A1.1: GROUND FLOOR PLAN
- A1.2: LOFT FLOOR PLAN A2.0: SOUTH & EAST EXTERIOR ELEVATIONS
- A2.1: NORTH & WEST EXTERIOR ELEVATIONS
- A3.0: BUILDING SECTIONS

SQUARE FOOTAGE CALCS. ZONING

TOTAL LOT SIZE	
BUILDING COVERAGE	
CONDITIONED MAIN FLOOR AREA	
COVERED FRONT PORCH	
COVERED BACK DECK AND STAIR	
DETACHED GARAGE	

TOTAL BUILDING COVERAGE	2,418 S.F
STEPS @ GARAGE	24 S.F.
CONCRETE PARKING RUNNERS	102 S.F.
WOOD TRASH DECK (1 / 2 S.F.)	40 S.F.
CONCRETE STEPS AND PADS	80 S.F.
CONCRETE FRONT STEPS	11S.F.
SITE WALLS	146 S.F.
A/C/ PAD	18 S.F.
IMPERVIOUS COVERAGE TOTAL ALLOWED @ 45% OF 7,111 S.F. =	3,200 S.F
IMPERVIOUS COVERACE TOTAL @ 40%	2 820 C E

3/200 811 1
2,839 S.F.
1,274 G.F.
1,274 G.F.
261 G.F.A
0 G.F.A.

2,844 G.F.A. 2,809 G.F.A. FLOOR AREA RATIO (FAR) TOTAL (ALLOWED) @ 40% OF 7,111 S.F. = FLOOR AREA RATIO (FAR) TOTAL (NEW) =

SITE NOTES

1. SITE PLAN BASED ON SURVEY PLAT OF 612 HIGHLAND AVENUE, AUSTIN TX 78703. LOT 12, BLOCK B, TERRACE PARK, A SUBDIVISION RECORDED N VOLUME 2, PAGE 242, PLAT RECORDS OF TRAVIS COUNTY. SITE INFORMATION BASED OFF OF SURVEY PERFORMED BY STUART W. WATSON, REGISTERED

- PROFESSIONAL LAND SURVEYOR (TEXAS LICENSE NUMBER 4550) ON FEBRUARY 18, 2016. 2. PROVIDE UNDERGROUND ELECTRICAL SERVICE FROM NEW ELECTRICAL UTILITY POLE. COORDINATE DESIGN & DETAILS WITH UTILITY COMPANY. COORDINATE LOCATION OF UTILITY LINES & PANEL
- LOCATIONS WITH ARCHITECT 3. PROTECT TREES, ROCK OUT CROPPINGS, AND NATURAL SITE FEATURES DURING CONSTRUCTION.
- MINIMIZE SITE DISTURBANCE TO PROJECT LIMIT LINE. 4. LIMIT AREAS OF STOCKPILED MATERIAL TO AREAS APPROVED BY ARCHITECT.

GOLOD

PERMIT

DOCUMENTS

REVISIONS

Civil Engineer

Mechanical Electrical & Plumbing Engineer NAME

Structural Engineer

NICK DEAVER Architect

606 Highland Avenue Austin, Texas 78703

T 512.494.9808

NAME Address Address

Address

NAME

Address Address


Residence 612 HIGHLAND DR. Austin, TX 78703

DRAWING NAME:

SITE PLAN

DRAWN BY:	AM
CHECKED BY:	ND
OB #:	248
FILE:	
FILE:	


O 2016 NICKDEAVERARCHITECT DATE: 03.31.2016

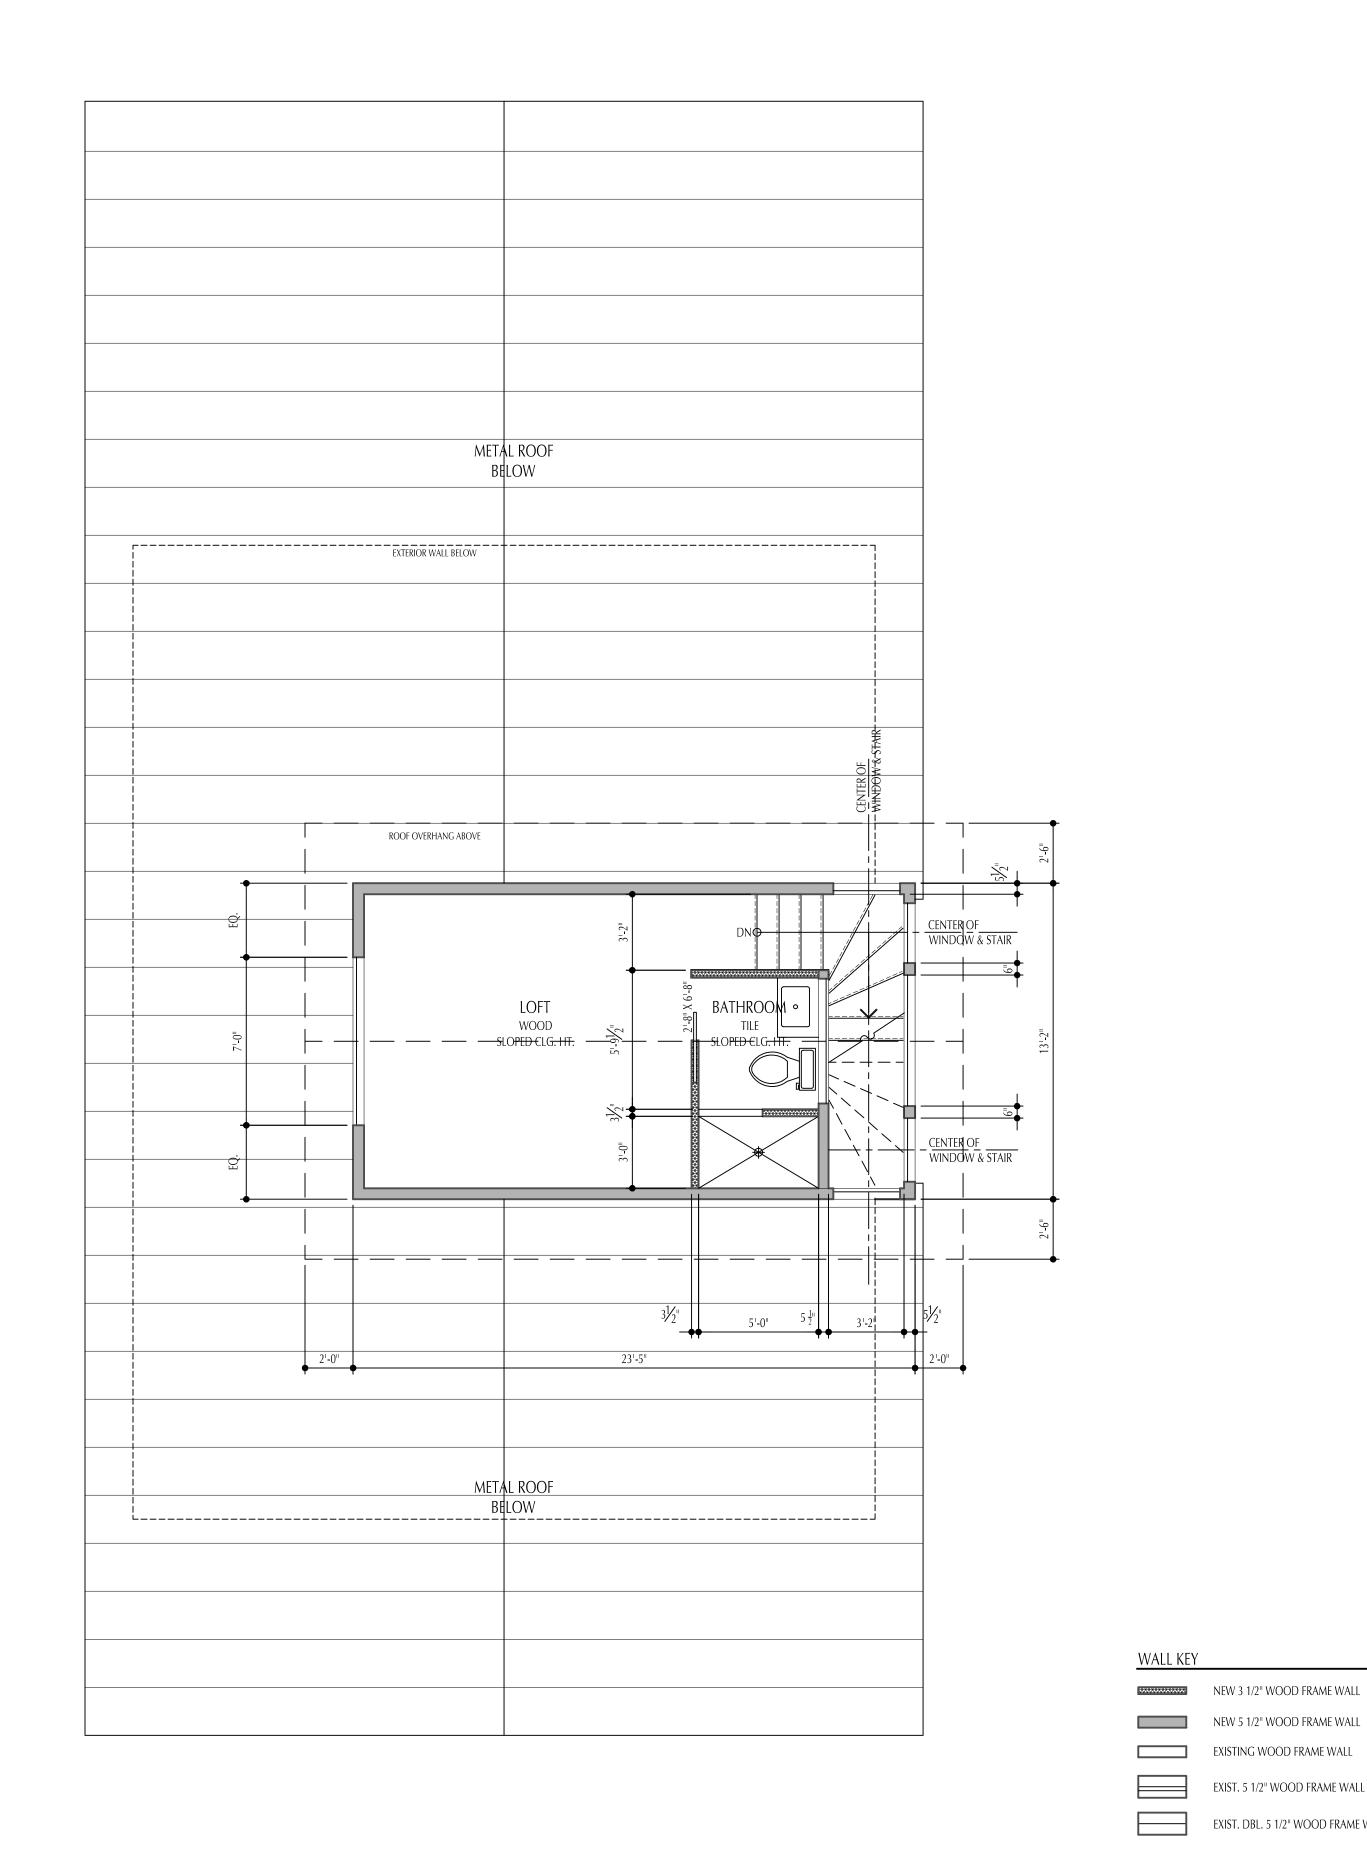

REVISIONS

Mechanical Electrical & Plumbing Engineer NAME

Structural Engineer

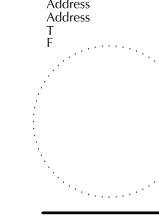

NICK DEAVER Architect

606 Highland Avenue Austin, Texas 78703 T 512.494.9808



PHASE:

PERMIT DOCUMENTS

GOLOD Residence

612 HIGHLAND DR. Austin, TX 78703

DRAWING NAME: LOFT PLAN

6X6 STEEL TUBE COLUMN (CONCEALED BASE)

■ 4X4 WD. POST

EXISTING WOOD FRAME WALL

EXIST. DBL. 5 1/2" WOOD FRAME WALL

EXIST. 5 1/2" WOOD FRAME WALL W/ 5 1/2" MASONRY LEDGE

DRAWN BY: AM
CHECKED BY: ND

2016 NICKDEAVERARCHITECT
DATE: 03.31.2016
SCALE:

LOFT PLAN

